

PROPOSED RESIDENCE FOR: LOGAN

LOT 59 DP1297467 No. 22 DRIFTWOOD BOULEVARD **OLD BAR 2430**

Bricks: Washed white PGH Newport Cladding: Surfmist Colorbond roof: Basalt Fascia & Gutter: Surfmist Garage door: Dover White Windows: Pearl White

Sheet List				
Sheet Number	Sheet Name			
00	COVER SHEET			
01-1	SITE PLAN			
01-2	LANDSCAPING PLAN			
01-3	STORMWATER PLAN			
02-1	FLOOR PLAN 1.125			
02-2	FLOOR PLAN 1.100 AT A2			
03-1	ELEVATIONS			
03-2	ELEVATIONS			
04-1	SECTION			
05-1	SLAB LAYOUT			
05-2	BRICKWORK SETOUT			
06	ELECTRICAL			
07-1	KITCHEN DETAILS UNIT 1			
07-2	KITCHEN DETAILS UNIT 2			
07-3	KITCHEN DETAILS UNIT 3			
08-1	WET AREA DETAILS UNIT 1			
08-2	WET AREA DETAILS UNIT 2			
08-3	WET AREA DETAILS UNIT 3			

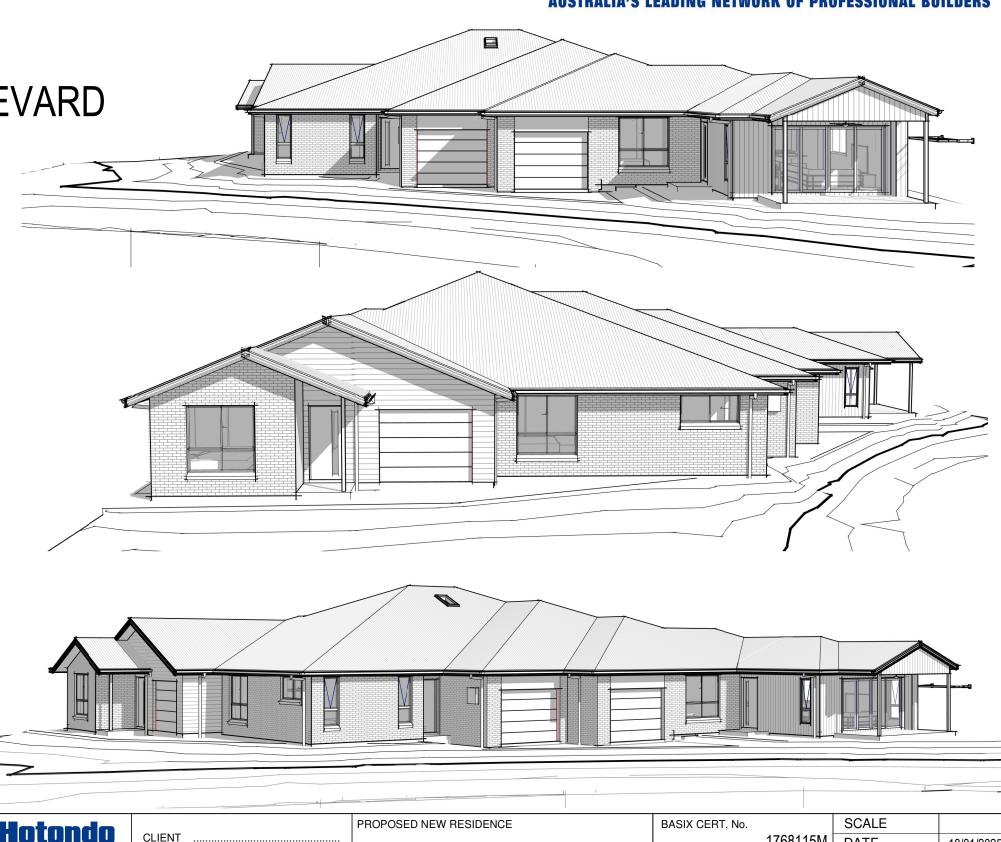

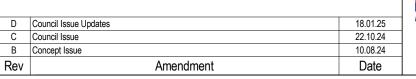

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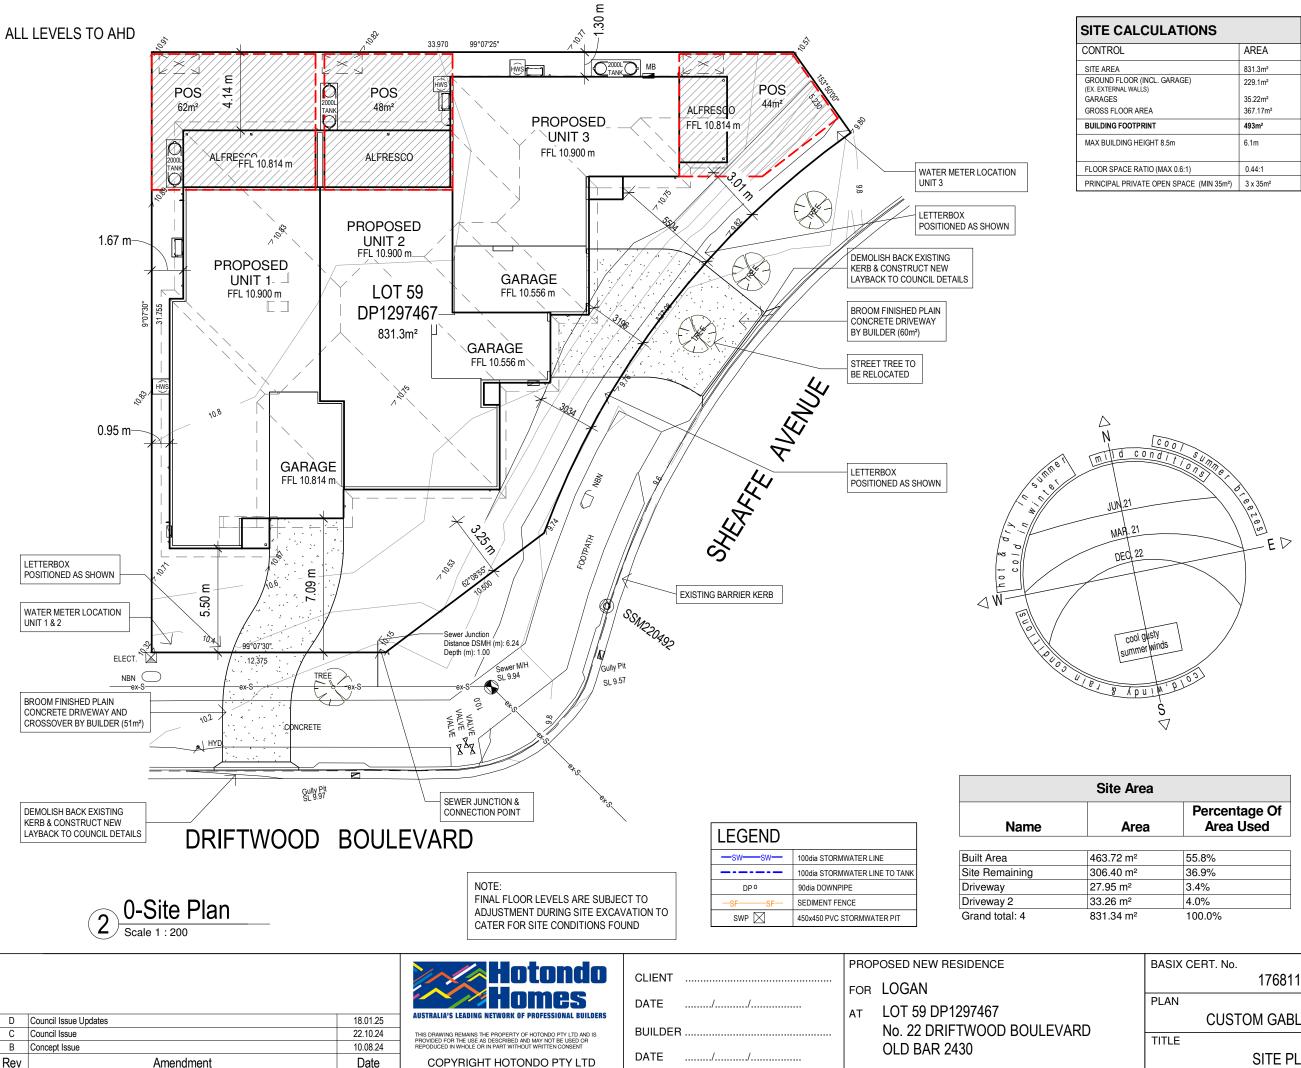
CLIENT	FOR	10
DATE/	FOR	
<i>D</i> , (12)	AT	LC
BUILDER		No
		0
DATE//		

OGAN

OT 59 DP1297467 lo. 22 DRIFTWOOD BOULEVARD LD BAR 2430



	BASIX CERT. No.	SCALE	
	1768115M	DATE	18/01/2025
	PLAN	DRAWN	T.J.W
	CUSTOM GABLES	DRAFT REF. No.	141-24
	TITLE	JOB No.	DWG No.
	COVER SHEET		00
Ī		•	



CULATIONS			
	AREA		
	831.3m ²		
NCL. GARAGE) ^{S)}	229.1m²		
	35.22m ²		
EA	367.17m²		
RINT	493m²		
IGHT 8.5m	6.1m		
TIO (MAX 0.6:1)	0.44:1		
TE OPEN SPACE (MIN 35m ²)	3 x 35m²		

STANDARD NOTES
1. ALL WRITTEN DIMENSION TAKE
PRECEDENCE OVER SCALE.
2. ALL ROOF BEAMS. LINTELS AND
BRICKWORK ANGLES TO TRUSS/WALL
FRAME MANUFACTURER'S SPECIFICATIONS
AND ENGINEERS VERIFICATION.
3. WC DOORS TO COMPLY WITH BCA VOL 2
PART 10.4.2. 4. ALL WET AREAS TO BE COMPLETED IN
4. ALL WET AREAS TO BE COMPLETED IN ACCORDANCE WITH BCA VOL 2 PT 10.2.
5. ENGINEER DESIGNED - PREFABRICATED
5. ENGINEER DESIGNED - PREFABRICATED
MANUFACTURER'S SPECIFICATIONS. (600
CTS UNLESS NOTED OTHERWISE).
6. 90mm PREFABRICATED TIMBER WALL
FRAMES AS PER MANUFACTURER'S
SPECIFICATIONS, U.N.O.
7. BUILDER & TRADES ARE TO CONFIRM ALL
MEASUREMENTS, DETAILS &
SPECIFICATIONS PRIOR TO SET-OUT BE
ORDERING OF MATERIALS.
8. REPORT ANY ERRORS FOR
CLARIFICATION/CORRECTION AS NO
RESPONSIBILITY WILL BE TAKEN AFTER
CONSTRUCTION HAS COMMENCED.
9. ALL ELECTRICAL APPLIANCE & PLUMBING SYMBOLS ARE DIAGRAMMATIC ONLY.
REFER TO BUILDERS SPECIFICATION FOR
DETAILS OF ALL FIXTURES.
10. SIZE AND LOCATION OF DOWNPIPES TO
BE CONFIRMED ON SITE BY BUILDER.
11. ALL WORK TO BE CONSTRUCTED IN
ACCORDANCE WITH THE BUILDING CODE
OF AUSTRALIA AND RELEVANT TRADE AND
TECHNICAL MANUALS.


ea	
	Percentage Of
а	Area Used

 55.8%
36.9%
3.4%
4.0%
100.0%

AREAS				
UNIT 1				
A	Living	123.40 m ²		
В	Garage	25.73 m ²		
С	Alfresco	21.72 m ²		
D	Porch	2.31 m ²		
UNIT 1	:4	173.15 m ²		
UNIT 2	2			
E	Living	116.06 m ²		
F	Garage	23.01 m ²		
G	Alfresco	20.67 m ²		
H Porch		0.98 m ²		
UNIT 2:4		160.73 m ²		
UNIT 3				
I	Living	90.63 m ²		
J	Garage	25.57 m ²		
К	Porch	2.18 m ²		
L	Alfresco	11.46 m ²		
UNIT 3	3:4	129.84 m ²		
Grand total: 12		463.72 m ²		

ROOF AREAS				
ROOF (PLAN AREA)	503 m ²			
ROOF (SLOPED AREA)	544 m ²			


SCALE	As indicated
DATE	18/01/2025
DRAWN	T.J.W
DRAFT REF. No.	141-24
JOB No.	DWG No. 01-1
	DATE DRAWN DRAFT REF. No.

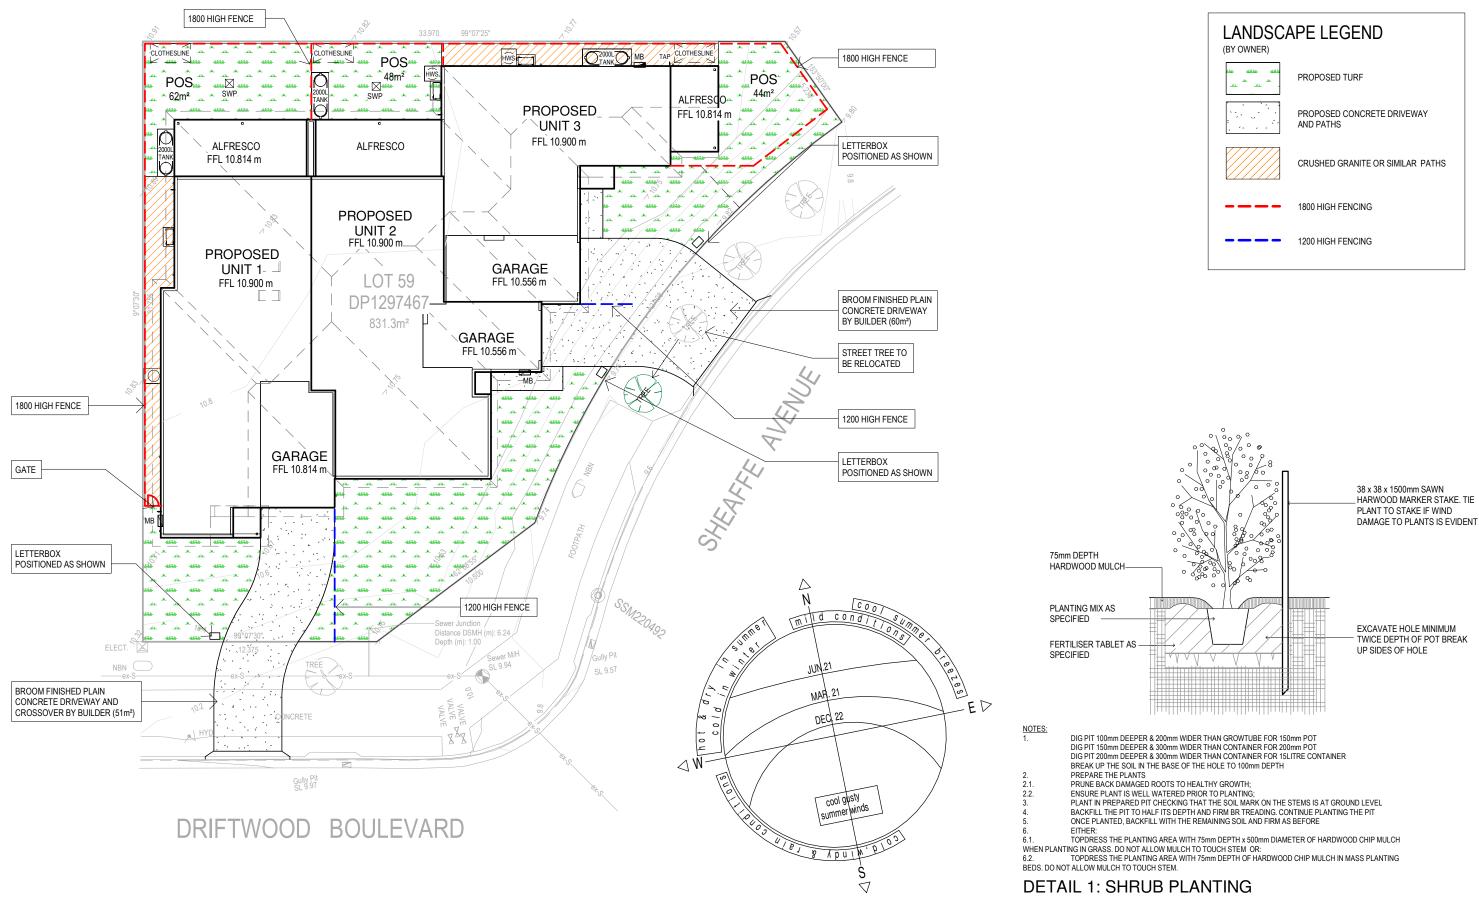

			Hotondo	CLIENT	P
			Homes	DATE///	F
D	Council Issue Updates	18.01.25	AUSTRALIA'S LEADING NETWORK OF PROFESSIONAL BUILDERS		A
С	Council Issue	22.10.24	THIS DRAWING REMAINS THE PROPERTY OF HOTONDO PTY LTD AND IS PROVIDED FOR THE USE AS DESCRIBED AND MAY NOT BE USED OR	BUILDER	
В	Concept Issue	10.08.24	REPODUCED IN WHOLE OR IN PART WITHOUT WRITTEN CONSENT		
Rev	Amendment	Date	COPYRIGHT HOTONDO PTY LTD	DATE//	

PROPOSED NEW RESIDENCE			
 FOR	LOGAN		
 AT	LOT 59 DP1297467		
	No. 22 DRIFTWOOD BOULEVARD OLD BAR 2430		

BASIX CERT. No.	SCALE	As indicated
1768115M	DATE	18/01/2025
PLAN	DRAWN	T.J.W
CUSTOM GABLES	DRAFT REF. No.	141-24
TITLE	JOB No.	DWG No.
LANDSCAPING PLAN		01-2

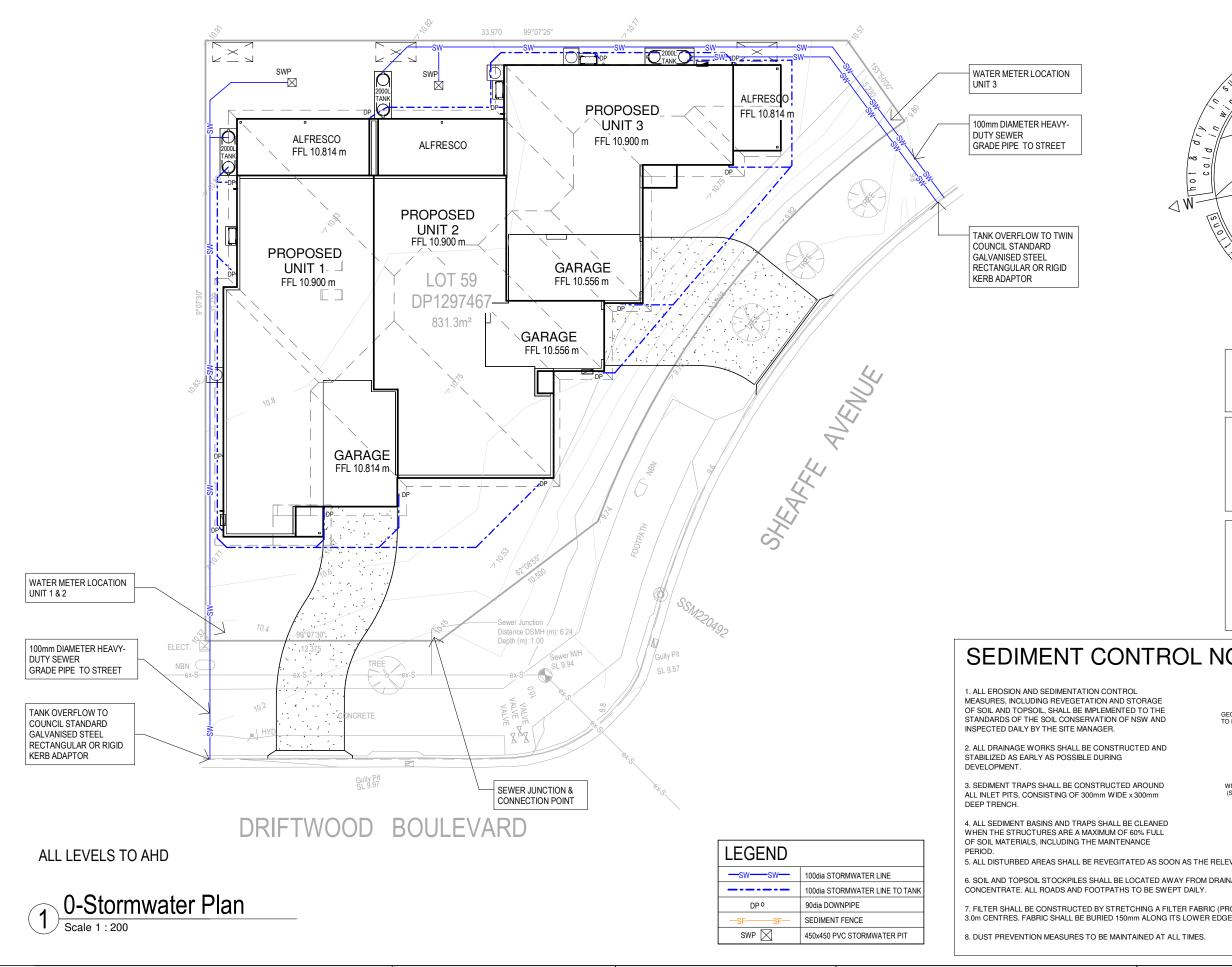


D	Council Issue Updates	18.01.25
С	Council Issue	22.10.24
В	Concept Issue	10.08.24
Rev	Amendment	Date



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COPYRIGHT HOTONDO PTY LTD

	PROF	POSED NEW RESIDENCE
CLIENT	FOR	LOGAN
DATE//	AT	LOT 59 DP1297467
BUILDER		No. 22 DRIFTWOOD
DATE///		OLD BAR 2430


 FOR	LOGAN
 AT	LOT 59 DP1297467 No. 22 DRIFTWOOD BOULEVARD
	OLD BAR 2430

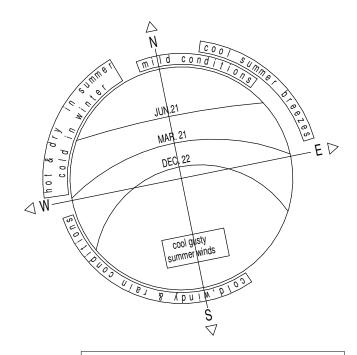


NOTE: SIZE AND LOCATION OF DOWNPIPES TO BE CONFIRMED ON SITE BY BUILDER.

NOTE: TEMPORARY SECURITY FENCING TO THE PERIMETER OF BOUNDARY WHERE REQUIRED TO PREVENT PUBLIC ACCESS ONTO SITE.

NOTE: ALL GROUND LINES ARE APPROXIMATE. EXTENT OF CUT AND FILL BATTERS WILL BE DETERMINED ON SITE. SEDIMENT BARRIERS ARE TO BE CUSTOMISED SITE SPECIFIC.

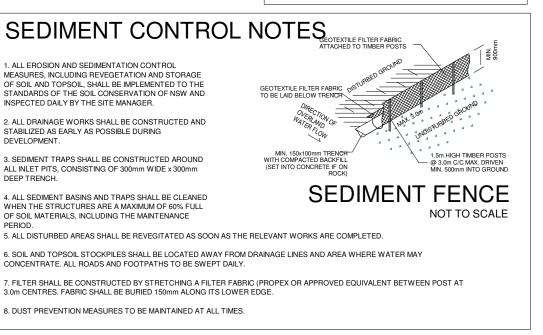

BASIX CERT. No.	SCALE	As indicated
1768115M	DATE	18/01/2025
PLAN	DRAWN	T.J.W
CUSTOM GABLES	DRAFT REF. No.	141-24
TITLE STORMWATER PLAN	JOB No.	DWG No. 01-3

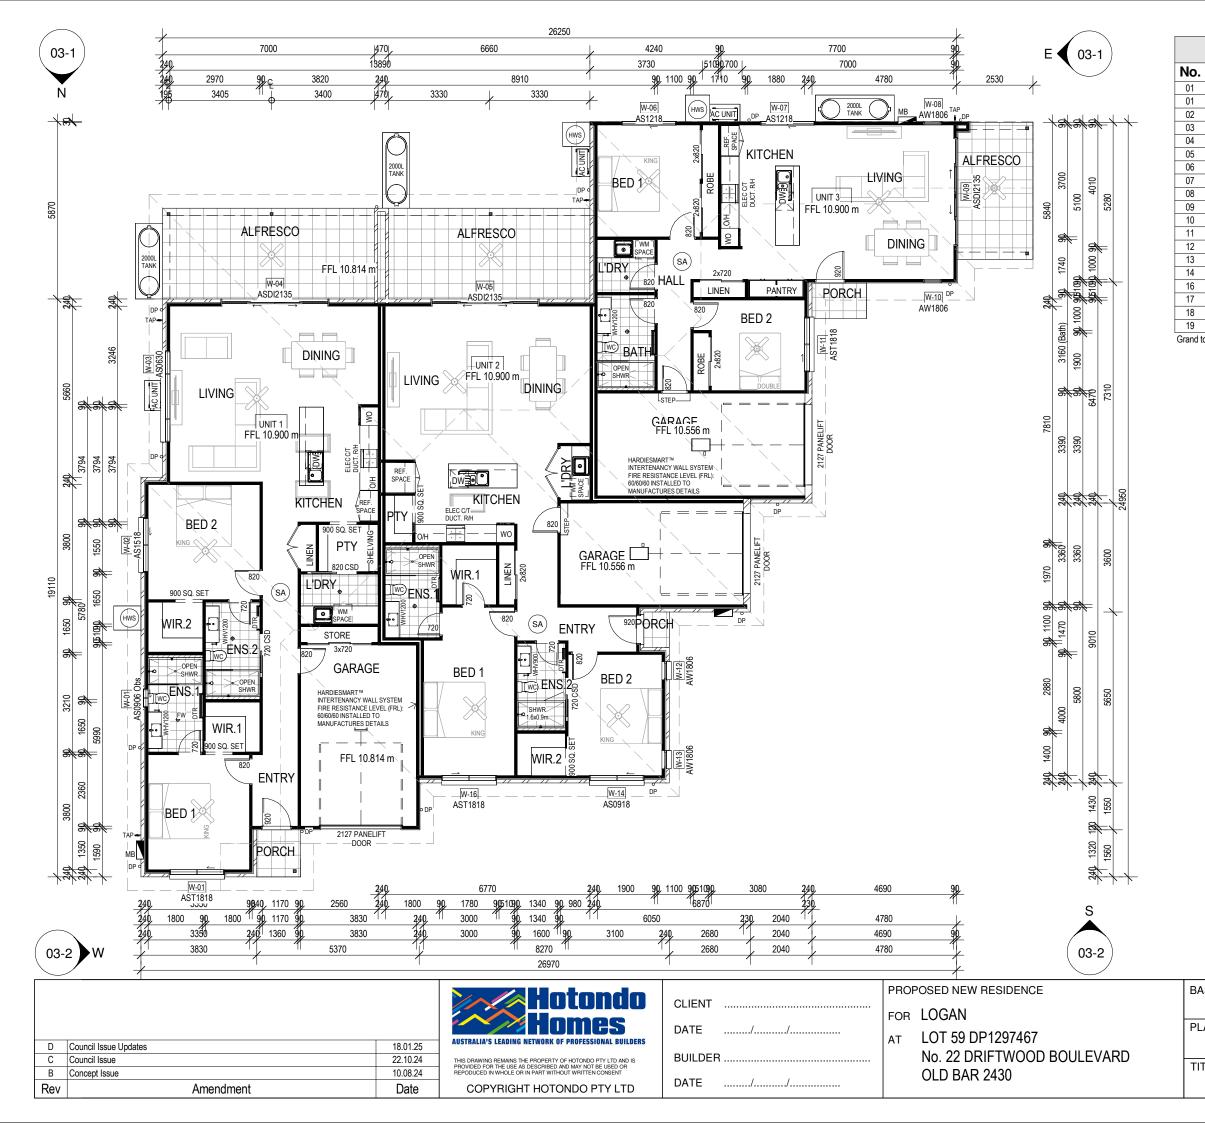


No.	Height	Width	Area	
01	860	610	0.52 m ²	
01	1800	1810	3.26 m ²	
02	1460	1810	2.64 m ²	
03	600	3010	1.81 m ²	
04	2100	3580	7.52 m ²	
05	2100	3580	7.52 m ²	
06	1200	1810	2.17 m ²	
07	1200	1810	2.17 m ²	
08	1800	610	1.10 m ²	
09	2100	3580	7.52 m ²	
10	1800	610	1.10 m ²	
11	1800	1810	3.26 m ²	
12	1800	600	1.08 m ²	
13	1800	600	1.08 m ²	
14 860		1810	1.56 m ²	
16	1800	1810	3.26 m ²	
17	1200	568	0.68 m ²	
18	1200	568	0.68 m ²	
19	1200	568	0.68 m ²	
Grand to	otal: 19		49.60 m ²	

LEGEND					
CPT	CARPET				
CT	CERAMIC TILES				
C/T	COOK TOP				
DP	DOWNPIPE				
DPS	DOWNPIPE & SPREADER				
DTR/TR	TOWEL RAIL (DOUBLE) / (SINGLE)				
HK	ROBE HOOK @ 1750				
FT	TIMBER LAMINATE FLOORING				
FFL	FINISHED FLOOR LEVEL				
GFL	GARAGE FLOOR LEVEL				
FW	FLOOR WASTE				
HWS	HEATPUMP HOT WATER SYSTEM				
MB	RECESSED ELECTRICAL METER BOX				
M/H	CEILING MANHOLE				
MX	MIXER				
O/H	OVERHEAD CUPBOARDS				
POL	POLISHED CONCRETE FLOOR				
RAIL	700mm SHOWER RAIL				
R/H	RANGEHOOD (DUCTED)				
S/D	SETDOWN				
ST	SERVICES STACK				
S	SPOUT				
Т	TAP				
RT	TOWEL RING @ 1100				
Trns	TRANSLUCENT GLASS				
TRH	TOILET ROLL HOLDER				
WM	WASHING MACHINE				
WC	TOILET				
VP	VINYL PLANK FLOORING				
V1200	VANITY & LENGTH				
WHV1200	WALL HUNG VANITY & LENGTH				
720 LOH	DOOR WITH LIFT OF HINGES				
720 P	DOOR WITH PRIVACY LOCK				
SA	SA SMOKE ALARM				
X	CEILING FAN LIGHT COMBO				

ROOF AREAS					
ROOF (PLAN AREA)	503 m ²				
ROOF (SLOPED AREA)	544 m²				

UNIT 1 A Living 123.40 m² B Garage 25.73 m² C Alfresco 21.72 m² D Porch 2.31 m² UNIT 1: 4 173.15 m² UNIT 2 E Living 116.06 m² F Garage 23.01 m² G Alfresco 20.67 m² H Porch 0.98 m² UNIT 2: 4 160.73 m² UNIT 3: 4 160.73 m² J Garage 25.57 m² K Porch 2.18 m² L Alfresco 11.46 m² UNIT 3: 4 129.84 m² Grand total: 12 BASIX CERT. No. SCALE As indicated DATE 18/01/2025			AREAS			
B Garage 25.73 m² C Alfresco 21.72 m² D Porch 2.31 m² UNIT 1: 4 173.15 m² UNIT 2 E Living F Garage 23.01 m² G Alfresco 20.67 m² H Porch 0.98 m² UNIT 2: 4 160.73 m² UNIT 3: 4 160.73 m² J Garage 25.57 m² K Porch 2.18 m² L Alfresco 11.46 m² UNIT 3: 4 129.84 m² Grand total: 12 BASIX CERT. No. SCALE As indicated	Ľ	UNIT 1				
C Alfresco 21.72 m² D Porch 2.31 m² UNIT 1: 4 173.15 m² UNIT 2 E Living E Living 116.06 m² F Garage 23.01 m² G Alfresco 20.67 m² H Porch 0.98 m² UNIT 2: 4 160.73 m² UNIT 3: 1 Living 90.63 m² J Garage 25.57 m² K Porch 2.18 m² L Alfresco 11.46 m² UNIT 3: 4 129.84 m² Grand total: 12 BASIX CERT. No. SCALE As indicated	A	١	Living	123.40 m ²		
D Porch 2.31 m² UNIT 1: 4 173.15 m² UNIT 2 E E Living 116.06 m² F Garage 23.01 m² G Alfresco 20.67 m² H Porch 0.98 m² UNIT 2: 4 160.73 m² UNIT 3 I Living 90.63 m² J Garage Z5.57 m² K VINIT 3: 4 129.84 m² UNIT 3: 4 129.84 m² Grand total: 12 463.72 m²	E	3	Garage	25.73 m ²		
Image: Construction of the second			Alfresco	21.72 m ²		
UNIT 2 E Living 116.06 m ² F Garage 23.01 m ² G Alfresco 20.67 m ² H Porch 0.98 m ² UNIT 2: 4 160.73 m ² UNIT 3: 4 160.73 m ² J Garage 25.57 m ² K Porch 2.18 m ² L Alfresco 11.46 m ² UNIT 3: 4 129.84 m ² Grand total: 12 463.72 m ² BASIX CERT. No.		·		2.31 m ²		
C G Living 116.06 m² F Garage 23.01 m² G Alfresco 20.67 m² H Porch 0.98 m² UNIT 2: 4 160.73 m² UNIT 3 I L Living 90.63 m² J Garage 25.57 m² K Porch 2.18 m² L Alfresco 11.46 m² UNIT 3: 4 129.84 m² Grand total: 12 463.72 m² BASIX CERT. No. SCALE As indicated	ī	JNIT 1	:4	173.15 m ²		
F Garage 23.01 m² G Alfresco 20.67 m² H Porch 0.98 m² UNIT 2: 4 160.73 m² UNIT 3 1 L Living 90.63 m² J Garage 25.57 m² K Porch 2.18 m² L Alfresco 11.46 m² UNIT 3: 4 129.84 m² Grand total: 12 463.72 m² BASIX CERT. No. SCALE As indicated						
G Alfresco 20.67 m² H Porch 0.98 m² UNIT 2: 4 160.73 m² UNIT 3 1 Living 90.63 m² J Garage Z5.57 m² K L Alfresco UNIT 3: 4 129.84 m² Grand total: 12 463.72 m² BASIX CERT. No. SCALE As indicated			<u> </u>	116.06 m ²		
C G H Porch 0.98 m² H Porch 0.98 m² UNIT 2: 4 160.73 m² UNIT 3 I Living 90.63 m² J J Garage 25.57 m² K Porch 2.18 m² L Alfresco 11.46 m² UNIT 3: 4 129.84 m² Grand total: 12 463.72 m² BASIX CERT. No. SCALE As indicated			Garage	23.01 m ²		
A F J Image: Construction of the construction of t				20.67 m ²		
A F J I Living 90.63 m² J Garage 25.57 m² I Living 90.63 m² J Garage 25.57 m² K Porch 2.18 m² L Alfresco 11.46 m² UNIT 3: 4 129.84 m² Grand total: 12 463.72 m² BASIX CERT. No. SCALE As indicated				0.98 m ²		
I Living 90.63 m² J Garage 25.57 m² K Porch 2.18 m² L Alfresco 11.46 m² UNIT 3: 4 129.84 m² Grand total: 12 463.72 m² BASIX CERT. No. SCALE As indicated						
J Garage 25.57 m² K Porch 2.18 m² L Alfresco 11.46 m² UNIT 3: 4 129.84 m² Grand total: 12 463.72 m² BASIX CERT. No. SCALE As indicated		JNIT 3				
K Porch 2.18 m² L Alfresco 11.46 m² UNIT 3: 4 129.84 m² Grand total: 12 463.72 m² BASIX CERT. No. SCALE As indicated			-			
L Alfresco 11.46 m² UNIT 3: 4 129.84 m² Grand total: 12 463.72 m² BASIX CERT. No. SCALE As indicated			0			
UNIT 3: 4 Grand total: 12 BASIX CERT. No. 17C0115M SCALE As indicated		(-		
Grand total: 12 463.72 m ² BASIX CERT. No. SCALE As indicated	L	-				
BASIX CERT. No. SCALE As indicated	-					
	G		total: 12	463.72 m ²		
1768115M DATE 18/01/2025		SC	ALE	As indicated		
	1768115M	DA	TE	18/01/2025		
PLAN DRAWN T.J.W		DRAWN		T.J.W		
CUSTOM GABLES DRAFT REF. No. 141-24	CUSTOM GABLES		AFT REF. No.	141-24		
TITLE JOB No. DWG No.	TITLE	JOB	3 No.	DWG No.		
FLOOR PLAN 1.125 02-1	FLOOR PLAN 1.125			02-1		

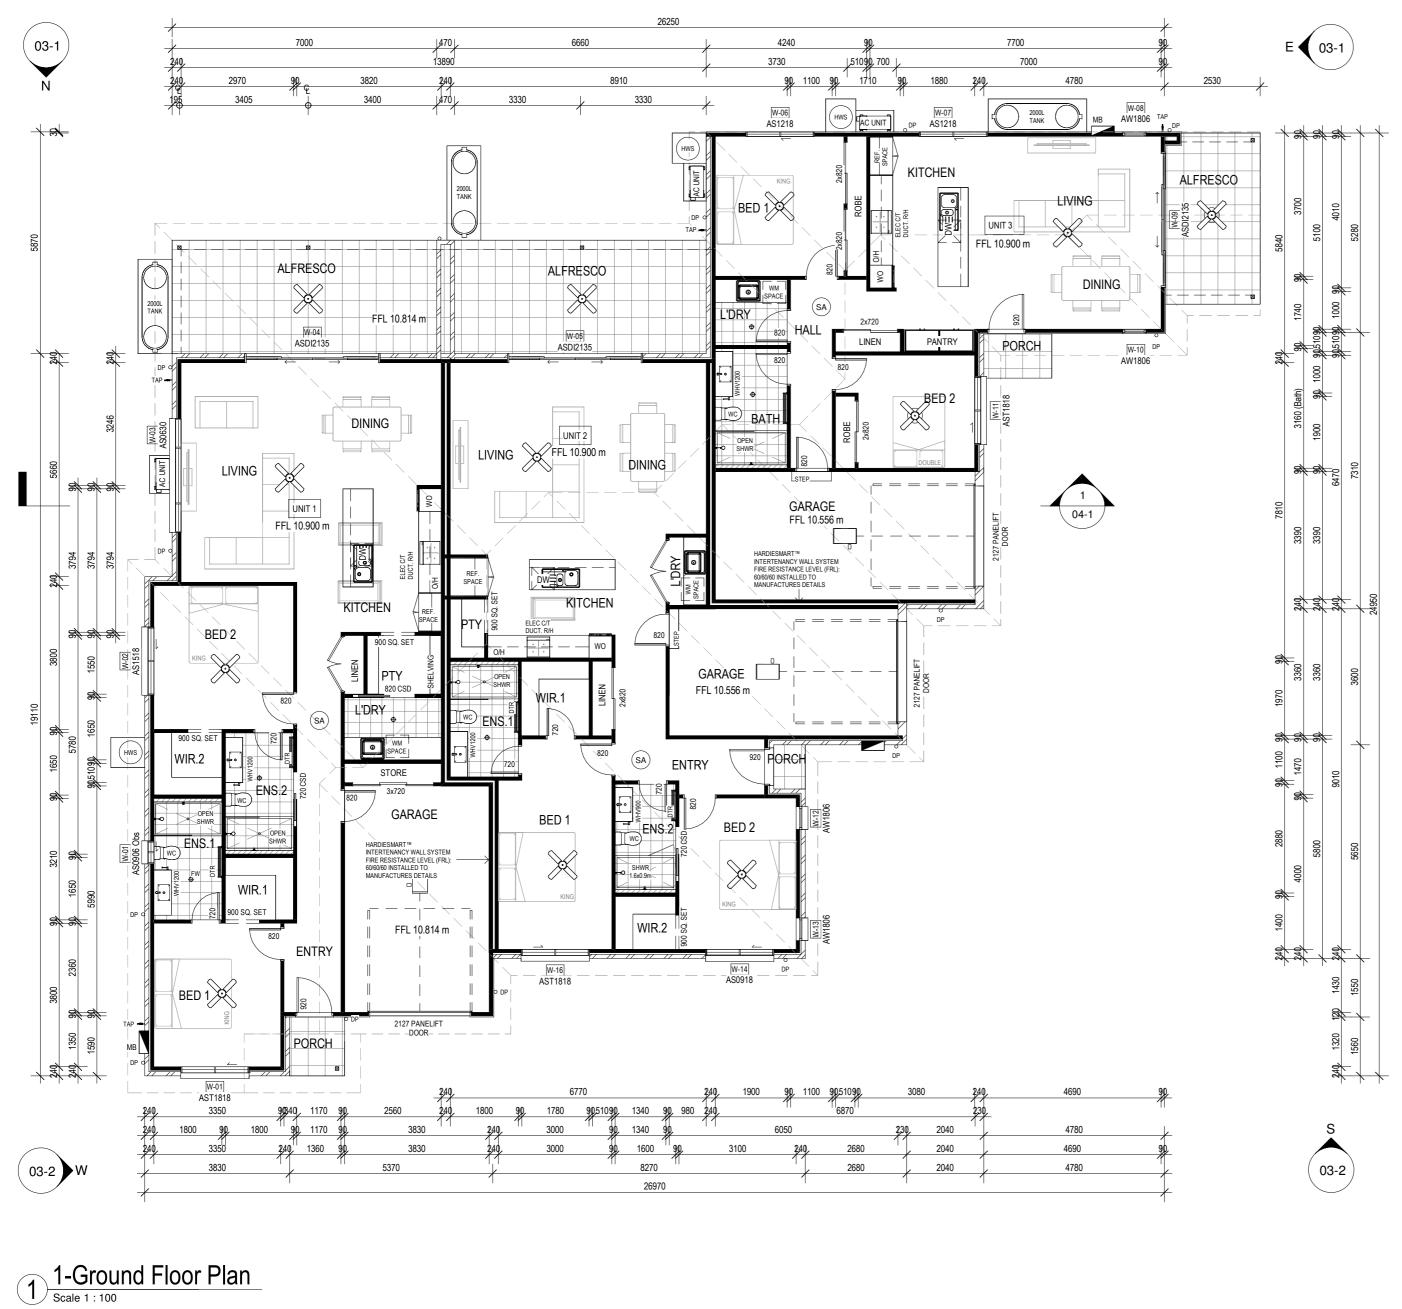

			Hotondo		PROF	POSED NEW RESIDENCE	BASIX CERT. No.	SCALE	As indicated
				CLIENT	FOR	LOGAN	1768115M	DATE	18/01/2025
			Homes	DATE///			PLAN	DRAWN	T.J.W
	Council Issue Updates	18.01.25	AUSTRALIA'S LEADING NETWORK OF PROFESSIONAL BUILDERS				CUSTOM GABLES	DRAFT REF. No.	4537
0	Council Issue	22.10.24	THIS DRAWING REMAINS THE PROPERTY OF HOTONDO PTY LTD AND IS PROVIDED FOR THE LISE AS DESCRIBED AND MAY NOT BE LISED OR	BUILDER		No. 22 DRIFTWOOD BOULEVARD			
E	Concept Issue	10.08.24	REPODUCED IN WHOLE OR IN PART WITHOUT WRITTEN CONSENT			OLD BAR 2430	TITLE	JOB No.	DWG No.
Re	v Amendment	Date	COPYRIGHT HOTONDO PTY LTD	DATE//			FLOOR PLAN 1.100 AT A2		02-2

		W	indow Schedule	
No.	Height	Width	Description	Area
01	860	610	Sliding Window	0.52 m ²
01	1800	1810	Sliding Window	3.26 m ²
02	1460	1810	Sliding Window	2.64 m ²
03	600	3010	Sliding Window	1.81 m ²
04	2100	3580	Sliding Door	7.52 m ²
05	2100	3580	Sliding Door	7.52 m ²
06	1200	1810	Sliding Window	2.17 m ²
07	1200	1810	Sliding Window	2.17 m ²
08	1800	610	Awning Window	1.10 m ²
09	2100	3580	Sliding Door	7.52 m ²
10	1800	610	Awning Window	1.10 m ²
11	1800	1810	Sliding Window	3.26 m ²
12	1800	600	Awning Window	1.08 m ²
13	1800	600	Awning Window	1.08 m ²
14	860	1810	Sliding Window	1.56 m ²
16	1800	1810	Sliding Window	3.26 m ²
17	1200	568	Fixed (non-operating) skylight	0.68 m ²
18	1200	568	Fixed (non-operating) skylight	0.68 m ²
19	1200	568	Fixed (non-operating) skylight	0.68 m ²
Grand to	otal: 19			49.60 m ²

Room Schedule

20.98 m²

12.73 m²

14.02 m²

11.71 m²

5.78 m²

5.78 m²

12.52 m²

22.94 m²

14.58 m²

4.22 m²

18.72 m²

2.25 m²

3.04 m²

2.97 m²

2.97 m²

155.22 m²

19.97 m²

16.00 m²

12.40 m²

15.87 m²

5.51 m²

4.61 m²

7.82 m²

20.33 m²

14.03 m²

1.76 m²

17.93 m²

0.98 m²

1.40 m²

3.51 m²

2.24 m²

144.37 m²

11.17 m²

6.00 m²

12.58 m²

11.00 m²

10.41 m²

23.29 m²

6.73 m²

14.36 m²

3.31 m²

15.60 m²

2.12 m²

116.57 m²

416.16 m²

UNIT 1 ALFRESCO

BED 1

BED 2

DINING

ENS.1

ENS.2

ENTRY

L'DRY

LIVING

PORCH

PTY

WIR.1

WIR.2

UNIT 1: 15

ALFRESCO

UNIT 2

BED 1

BED 2

DINING

ENS.1

ENS.2

ENTRY

GARAGE

KITCHEN

L'DRY

LIVING

PORCH

PTY

WIR.1

WIR.2

UNIT 3

BATH

BED 1

BED 2

DINING

HALL

L'DRY

LIVING

PORCH

UNIT 3: 11

Grand total: 41

GARAGE

KITCHEN

UNIT 2: 15

ALFRESCO

GARAGE


KITCHEN

scription	Area	CT	CERAMIC TILES	
	0.52 m ²	_C/T	COOK TOP	
	3.26 m ²	DP		
	2.64 m ²	DPS	DOWNPIPE & SPREADER	
	1.81 m ²	DTR/TR		(SINGLE)
		HK	ROBE HOOK @ 1750	PING
	7.52 m ²	FT FFL	TIMBER LAMINATE FLOO FINISHED FLOOR LEVEL	
	7.52 m ²	GFL	GARAGE FLOOR LEVEL	
	2.17 m ²	FW	FLOOR WASTE	
	2.17 m ²			OVOTEM
	1.10 m ²	HWS	HEATPUMP HOT WATER	
	7.52 m ²	MB M/H	RECESSED ELECTRICAL CEILING MANHOLE	IVIE I EK BUX
	1.10 m ²	MX		
	3.26 m ²	O/H	OVERHEAD CUPBOARDS	
	1.08 m ²	POL	POLISHED CONCRETE FI	LOOR
	1.08 m ²	RAIL	700mm SHOWER RAIL	
	1.56 m ²	R/H	RANGEHOOD (DUCTED)	
		S/D	SETDOWN	
ine) els Polst	3.26 m ²	ST	SERVICES STACK	
ting) skylight	0.68 m ²	S	SPOUT	
ing) skylight	0.68 m ²	Т	TAP	
ing) skylight	0.68 m ²	RT	TOWEL RING @ 1100	
	49.60 m ²	Trns	TRANSLUCENT GLASS	
		TRH	TOILET ROLL HOLDER	
		WM	WASHING MACHINE	
		WC	TOILET	
		VP	VINYL PLANK FLOORING	
		_V1200	VANITY & LENGTH	
			WALL HUNG VANITY & LE	NGTH
		720 LOH	DOOR WITH LIFT OF HINC	
		720 P	DOOR WITH PRIVACY LO	СК
		(SA)	SMOKE ALARM	
			CEILING FAN LIGHT COMBO	CEILING FAN
				S
		ROOF	ROOF ARE	EAS 503 m ²
		ROOF		503 m ²
			(PLAN AREA) AREAS	503 m ²
		UNIT	(PLAN AREA) AREAS	503 m ²
		UNIT	(PLAN AREA) AREAS Living	503 m ²
	↓ ↓ ↓	UNIT	(PLAN AREA) AREAS	503 m ²
C G		UNIT A B	(PLAN AREA) AREAS Living Garage	503 m ²
C G		UNIT A B C	(PLAN AREA) AREAS Living Garage Alfresco	503 m ² 123.40 m ² 25.73 m ² 21.72 m ²
F		UNIT A B C D	Performance (PLAN AREA)	503 m ² 123.40 m ² 25.73 m ² 21.72 m ² 2.31 m ²
		UNIT A B C	Performance (PLAN AREA)	503 m ² 123.40 m ² 25.73 m ² 21.72 m ²
		UNIT A B C D UNIT	Performance (PLAN AREA)	503 m ² 123.40 m ² 25.73 m ² 21.72 m ² 2.31 m ²
		UNIT A B C D UNIT UNIT	Porch (PLAN AREA) AREAS AREAS AREAS AREAS AREAS AREAS AREAS AREAS	503 m ² 123.40 m ² 25.73 m ² 21.72 m ² 2.31 m ² 173.15 m ²
		UNIT A B C UNIT UNIT E	Porch 1 Living AREAS AREAS AREAS Porch 1: 4 2 Living Living	503 m ² 123.40 m ² 25.73 m ² 21.72 m ² 2.31 m ² 173.15 m ² 116.06 m ²
		UNIT A B C D UNIT UNIT	Porch (PLAN AREA) AREAS AREAS AREAS AREAS AREAS AREAS AREAS AREAS	503 m ² 123.40 m ² 25.73 m ² 21.72 m ² 2.31 m ²
		UNIT A B C D UNIT UNIT E F	I Living Garage Alfresco Porch 1: 4 2 Living Garage	503 m ² 123.40 m ² 25.73 m ² 21.72 m ² 2.31 m ² 173.15 m ² 116.06 m ² 23.01 m ²
		UNIT A B C UNIT UNIT E	Porch 1 Living AREAS AREAS AREAS Porch 1: 4 2 Living Living	503 m ² 123.40 m ² 25.73 m ² 21.72 m ² 2.31 m ² 173.15 m ² 116.06 m ²

LEGEND


CPT CARPET CT CERAMIC TILES

0		2.01111
UNIT 1:4		173.15 m ²
UNIT 2		
E	Living	116.06 m ²
F	Garage	23.01 m ²
G	Alfresco	20.67 m ²
Н	Porch	0.98 m ²
UNI	Г 2: 4	160.73 m ²
UNI	Г 3	
I	Living	90.63 m ²
J	Garage	25.57 m ²
K	Porch	2.18 m ²
L	Alfresco	11.46 m ²
UNIT 3: 4		129.84 m ²
Grar	nd total: 12	463.72 m ²

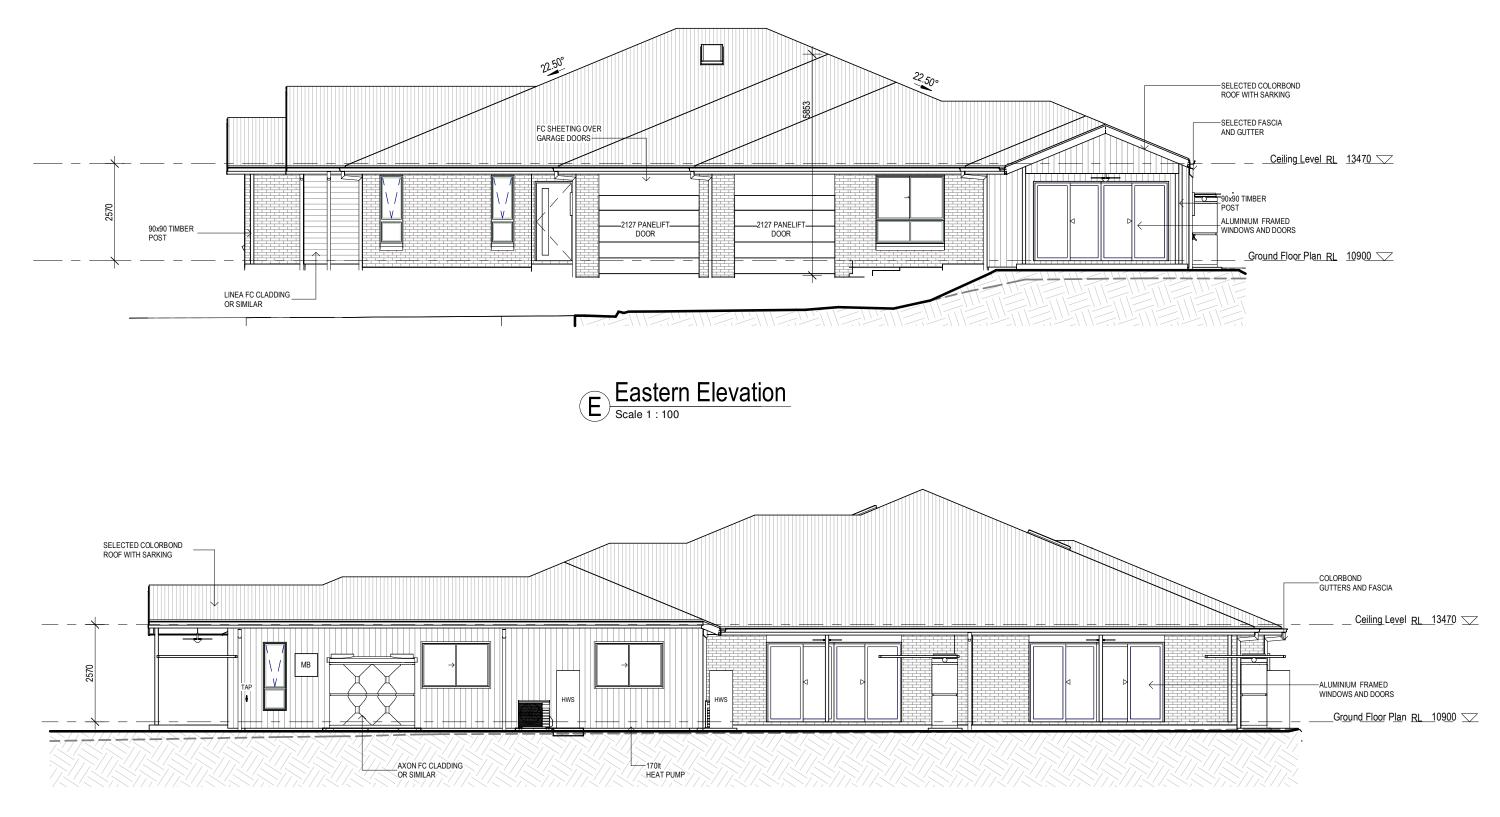




			Moton H		PROPOSED NEW RESIDENCE	BASIX CERT. No.	SCALE	1 : 100
			HULUIIUU	CLIENT	FOR LOGAN	1768115M	DATE	18/01/2025
			HOMES	DATE///	AT LOT 59 DP1297467	PLAN	DRAWN	T.J.W
D	Council Issue Updates	18.01.25	AUSTRALIA'S LEADING NETWORK OF PROFESSIONAL BUILDERS			CUSTOM GABLES	DRAFT REF. No.	141-24
С	Council Issue	22.10.24	THIS DRAWING REMAINS THE PROPERTY OF HOTONDO PTY LTD AND IS PROVIDED FOR THE USE AS DESCRIBED AND MAY NOT BE USED OR	BUILDER	No. 22 DRIFTWOOD BOULEVARD	TITLE		
В	Concept Issue	10.08.24	REPODUCED IN WHOLE OR IN PART WITHOUT WRITTEN CONSENT		OLD BAR 2430		JOB No.	DWG No.
Rev	Amendment	Date	COPYRIGHT HOTONDO PTY LTD	DATE///		ELEVATIONS		03-1

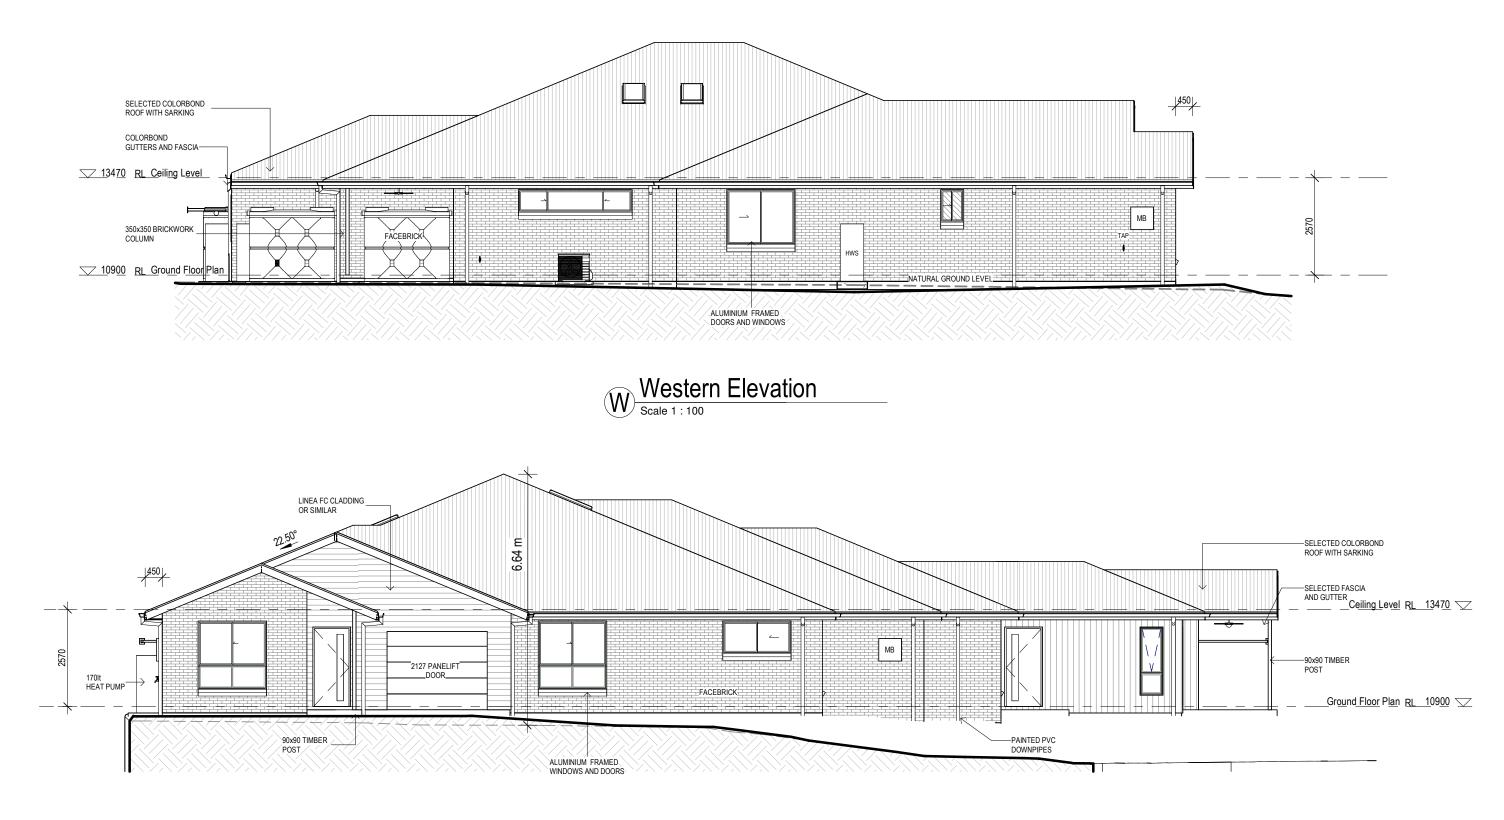



		Hotondo		PROPOSED NEW RESIDENCE	BASIX CERT. No.	SCALE	1 : 100
		notonuo	CLIENT	FOR LOGAN	1768115M	DATE	18/01/2025
		HOMES	DATE///	AT LOT 59 DP1297467	PLAN	DRAWN	T.J.W
D	Council Issue Updates 18.01.25	AUSTRALIA'S LEADING NETWORK OF PROFESSIONAL BUILDERS			CUSTOM GABLES	DRAFT REF. No.	141-24
С	Council Issue 22.10.24	THIS DRAWING REMAINS THE PROPERTY OF HOTONDO PTY LTD AND IS PROVIDED FOR THE LISE AS DESCRIBED AND MAY NOT BE LISED OR	BUILDER	No. 22 DRIFTWOOD BOULEVARD	TITLE		
В	Concept Issue 10.08.24	REPODUCED IN WHOLE OR IN PART WITHOUT WRITTEN CONSENT		OLD BAR 2430		JOB No.	DWG No.
Rev	Amendment Date	COPYRIGHT HOTONDO PTY LTD	DATE		ELEVATIONS		03-2

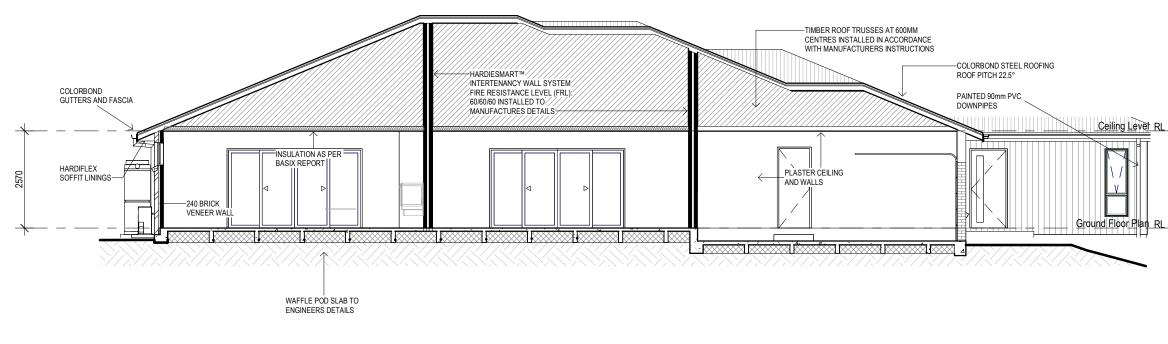

Typical Section $(\mathbf{1})$

			1	
No.	Height	Width	Description	Area
01	860	610	Sliding Window	0.52 m ²
01	1800	1810	Sliding Window	3.26 m ²
02	1460	1810	Sliding Window	2.64 m ²
03	600	3010	Sliding Window	1.81 m ²
04	2100	3580	Sliding Door	7.52 m ²
05	2100	3580	Sliding Door	7.52 m ²
06	1200	1810	Sliding Window	2.17 m ²
07	1200	1810	Sliding Window	2.17 m ²
08	1800	610	Awning Window	1.10 m ²
09	2100	3580	Sliding Door	7.52 m ²
10	1800	610	Awning Window	1.10 m ²
11	1800	1810	Sliding Window	3.26 m ²
12	1800	600	Awning Window	1.08 m ²
13	1800	600	Awning Window	1.08 m ²
14	860	1810	Sliding Window	1.56 m ²
16	1800	1810	Sliding Window	3.26 m ²
17	1200	568	Fixed (non-operating) skylight	0.68 m ²
18	1200	568	Fixed (non-operating) skylight	0.68 m ²
19	1200	568	Fixed (non-operating) skylight	0.68 m ²
Grand to	otal: 19			49.60 m ²

BASIX SUMMARY	DWELLING		
	1	2	3
No. of Bedrooms	2	2	2
Net Conditioned Floor Area	119.18	114.5	81.51
Net Unconditioned Floor Area	28.25	23.41	22.74
Landscaped Area	90	94	57
Indiginous Planting required	0	0	0
Shower Head Rating	3 star (>7.5 <= 9 L/m)	3 star (>7.5 <= 9 L/m)	3 star (>7.5 <= 9 L/m)
Toilets Rating	4 Star	4 Star	4 Star
Tap Fitting Kitchen	5 Star	5 Star	5 Star
Tap Fitting Bathroom	4 Star	4 Star	4 Star
Water Tank	2000L	2000L	1500L
Tank Water Usage	Outdoor, WC, WM	Outdoor, WC, WM	Outdoor, WC, WM
Hot Water Unit	Heatpump	Heatpump	Heatpump
Thermal Comfort	NatHERS	NatHERS	NatHERS
Air Conditioning	Yes	Yes	Yes
Mechanical Ventilation (Fans)	Yes	Yes	Yes
Ventilation Bathroom	Fan, Ducted	Fan, Ducted	Fan, Ducted
Ventilation Kitchen	Fan, Ducted	Fan, Ducted	Fan, Ducted
Ventilation Laundry	Fan, Ducted	Fan, Ducted	Fan, Ducted
Cooktop	Induction	Induction	Induction
Oven	Electric	Electric	Electric
Clothes Line Outdoor/Sheltered	Outdoor	Outdoor	Outdoor
Alternative Energy	N/A	N/A	N/A



D	Council Issue Updates	18.01.25
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В	Concept Issue	10.08.24
Rev	Amendment	Date

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DATE		AT	
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DATE			С


PROPOSED NEW RESIDENCE

OGAN

_OT 59 DP1297467 No. 22 DRIFTWOOD BOULEVARD OLD BAR 2430

	GENERAL SPECIFICATION
	SPECIFICATIONS GENERAL - IT IS RESPONSIBILITY OF BUILDER TO VERIFY ALL DOCUMENTS AS TO THEIR ACCURACY AND SUITABILITY - PLANS TO BE READ IN CONJUNCTION WITH STRUCTURAL ENGINEERS DRAWINGS AND ALL OTHER RELEVANT CONSULTANTS DRAWINGS WHERE APPLICABLE. - NCC - NATIONAL CONSTRUCTION CODE - VOLUME 2 - HOUSING PROVISIONS - IF ANY DISCREPANCY, AMBIGUITY, ERROR OR INCONSISTENCY IS FOUND IN THIS SET OF DRAWINGS, REPORT TO HPC BEFORE PROCEEDING. -ALL DIMENSIONS TO BE VERIFIED BEFORE ANY WORK OR FABRICATION COMMENCES.
13470 💟	STATUTORY REQUIREMENTS - ALL WORK TO BE CARRIED OUT IN ACCORDANCE WITH THE NCC CONDITIONS IMPOSED BY LOCAL AUTHORITY, & COMMITMENTS NOTED IN RELEVANT BASIX CERTIFICATE - THE BUILDER IS TO COMPLY WITH REQUIREMENTS OF ALL LEGALLY CONSTITUTED AUTHORITIES HAVING JURISDICTION OVER BUILDING WORKS AND PROVISIONS OF THE HOME BUILDING ACT. - BUILDER STALL PROVIDE TEMPORARY TOILET FACILITIES FOR THE USE OF THE SUBCONTRACTORS
_ 1 <u>0900 </u>	NCC REQUIREMENTS - ALL EARTHWORKS SHALL BE IN ACCORDANCE WITH ENGINEER'S DETAILS & PART 3.2 OF NCC. ALL EXCAVATIONS & UNDERFLOOR FILL SHALL BE IN ACCORDANCE WITH ENGINEER'S DETAILS & PART 3.1.1 OF NCC - PRIMARY BUILDING ELEMENTS TO BE PROTECTED FROM SUBTERRENEAN TERMITES IN ACCORDANCE WITH PART 3.4 OF NCC - PROVIDE ADEQUATE CROSS VENTILATION TO SPACE UNDER SUSPENDED GROUND FLOORS IN ACCORDANCE WITH PART 6.2.1 OF NCC - STORMWATER DRAINAGE SHALL BE CARRIED OUT IN ACCORDANCE WITH PART 3.3 OF NCC
	- ALL TIMBER FRAMEWORK SHALL COMPLY WITH NCC OR AS1684 - ROOF TRUSSES SHALL BE DESIGNED IN ACCORDANCE WITH AS1720 & INSTALLED IN ACCORDANCE TO MANUFACTURER'S SPECIFICATIONS - STRIP & SHEET FLOORING SHALL BE INSTALLED IN ACCORDANCE WITH AS1684 - STEEL FRAMING SHALL BE IN ACCORDANCE WITH MANUFACTURER'S SPECIFICATIONS - ALL ROOF CLADDING SHALL OB IN ACCORDANCE WITH MANUFACTURER'S SPECIFICATIONS - GUTTERS & DOWNPIPES SHALL OBLEVIEV WITH PART 7 OF NCC, & INSTALLED IN ACCORDANCE TO MANUFACTURER'S SPECIFICATIONS - GUTTERS & DOWNPIPES SHALL BE IN ACCORDANCE WITH MANUFACTURER'S SPECIFICATIONS - GUTTERS & DOWNPIPES SHALL BE IN ACCORDANCE WITH PART 7.4 OF NCC SARKING SHALL COMPLY WITH ASINZS4200.1 & 2 - FLASHING SHALL COMPLY WITH ASINZS4200.1 & 2 - FLASHING SHALL COMPLY WITH ASINZS4200.1 & 2 - CONCRETE BLOCK WORK SHALL COMPLY WITH FITHER AS4773 OR AS3700 - CLAY BRICK WORK SHALL COMPLY WITH FITHER AS4773 OR AS3700 - AUTOCLAVED AERATED CONCRETE PRODUCTS SHALL E INSTALLED IN ACCORDANCE WITH MANUFACTURER'S SPECIFICATIONS AS 5416.1 - DAMP PROOF COURSES & CAVITY VENTILATION SHALL COMPLY WITH EITHER AS4773
	OR AS3700 - MORTAR & JOINT TOLERANCES SHALL BE IN ACCORDANCE WITH EITHER AS4773 OR AS3700 - MASONRY ACCESSORIES SHALL COMPLY WITH EITHER AS4773 OR AS3700 APPROPRIATE TIES SHALL BE PROVIDED TO ARTICULATED MASONRY JOINTS - LINTELS USED TO SUPPORT BRICKWORK OVER OPENINGS & BE PROTECTED FROM CORROSION SHALL COMPLY WITH EITHER AS4773 OR AS3700 - MASONRY VENEER SHALL COMPLY WITH PART 5.2 OF NCC - ENGAGED PIERS IN SINGLE LEAF MASONRY WALLS SHALL BE CONSTRUCTED IN ACCORDANCE WITH EITHER AS4773 OR AS3700 - INTERNAL WET AREAS TO BE WATERPROOFED IN ACCORDANCE WITH PART 10.2 OF NCC. WET AREA WALL LINING TO BE FIXED IN ACCORDANCE WITH MANUFACTURERS SPECIFICATIONS - BALCONIES OVER HABITABLE ROOMS TO BE WATERPROOFED IN ACCORDANCE WITH PART H208 OF NCC. - ALL TIMBER DOOR & DOOR SETS SHALL BE MANUFACTURED IN ACCORDANCE WITH AS2688 & AS2689 UNLESS NOTED OTHERWISE IN THE SCHEDULE OF WORKS - WINDOWS & DOORS SHALL BE MANUFACTURED & INSTALLED IN ACCORDANCE WITH
	AS 2047 - ALL GLAZING SHALL COMPLY WITH PART 8.3 OF NCC - STAIR & RAMP CONSTRUCTION SHALL BE IN ACCORDANCE WITH PART 11.2 OF NCC - BALUSTRADES SHALL BE IN ACCORDANCE WITH PART 11.3 AND H5D3 OF NCC - ALL PLUMBING SHALL COMPLY WITH REQUIREMENTS OF RELEVANT SUPPLY AUTHORITY & AS3500, & BE CARRIED OUT BY A LICENSED PLUMBER - ALL ELECTRICAL WORK SHALL COMPLY WITH REQUIREMENTS OF RELEVANT SUPPLY AUTHORITY & AS3000 & BE CARRIED OUT BY LICENSED ELECTRICAN - ALL GAS INSTALLATIONS SHALL COMPLY WITH REQUIREMENTS OF RELEVANT SUPPLY AUTHORITY, & BE CARRIED OUT BY A LICENSED GAS FITTER - PROVIDE & INSTALL HARD WIRED SMOKE ALARMS IN ACCORDANCE WITH AS3786 & PART 9.5 OF NCC - INSTALLATION OF WALL & FLOOR TILES SHALL BE IN ACCORDANCE WITH AS3858.1 - BUILDING TO BE SEALED TO THE REQUIREMENTS OF PART 13.4 OF NCC, INCLUDING
	CHIMNEY'S, FLUES, ROOF LIGHTS, EXTERNAL WINDOWS & DOORS, EXHAUST FANS, ROOF, WALLS, & FLOORS. - SERVICES ARE TO BE INSTALLED TO THE REQUIREMENTS OF NSW PART 3.12.5 OF BCA, INCLUDING HOT WATER SUPPLY, INSULATION OF SERVICES, CENTRAL HEATING WATER PIPING, HEATING & COOLING DUCTWORK - MECHANICAL VENTILATION IS TO BE INSTALLED IN ACCORDANCE WITH PART H4D7 OF NCC - INWARD SWINGING WC DOORS ARE TO BE FITTED WITH LIFT OFF HINGES TO COMPLY WITH PART 10.4.2 OF NCC - CONDENSATION MANAGEMENT TO COMPLY WITH PART F8 OF NCC - WALL CLADDING TO COMPLY WITH PART 7.5 OF NCC
	PLEASE NOTE: THE STANDARDS REFERENCED IN THE TABLE ARE THE RELEVANT VERSION ADOPTED BY THE NCC AT THE TIME THE CONSTRUCTION CERTIFICATE OR COMPLYING DEVELOPEMNT CERTIFICATE APPLICATION WAS LODGED.

BASIX CERT. No.		SCALE	1 : 100
	1768115M	DATE	18/01/2025
PLAN		DRAWN	T.J.W
CUS	TOM GABLES	DRAFT REF. No.	141-24
TITLE		JOB No.	DWG No.
	SECTION		04-1

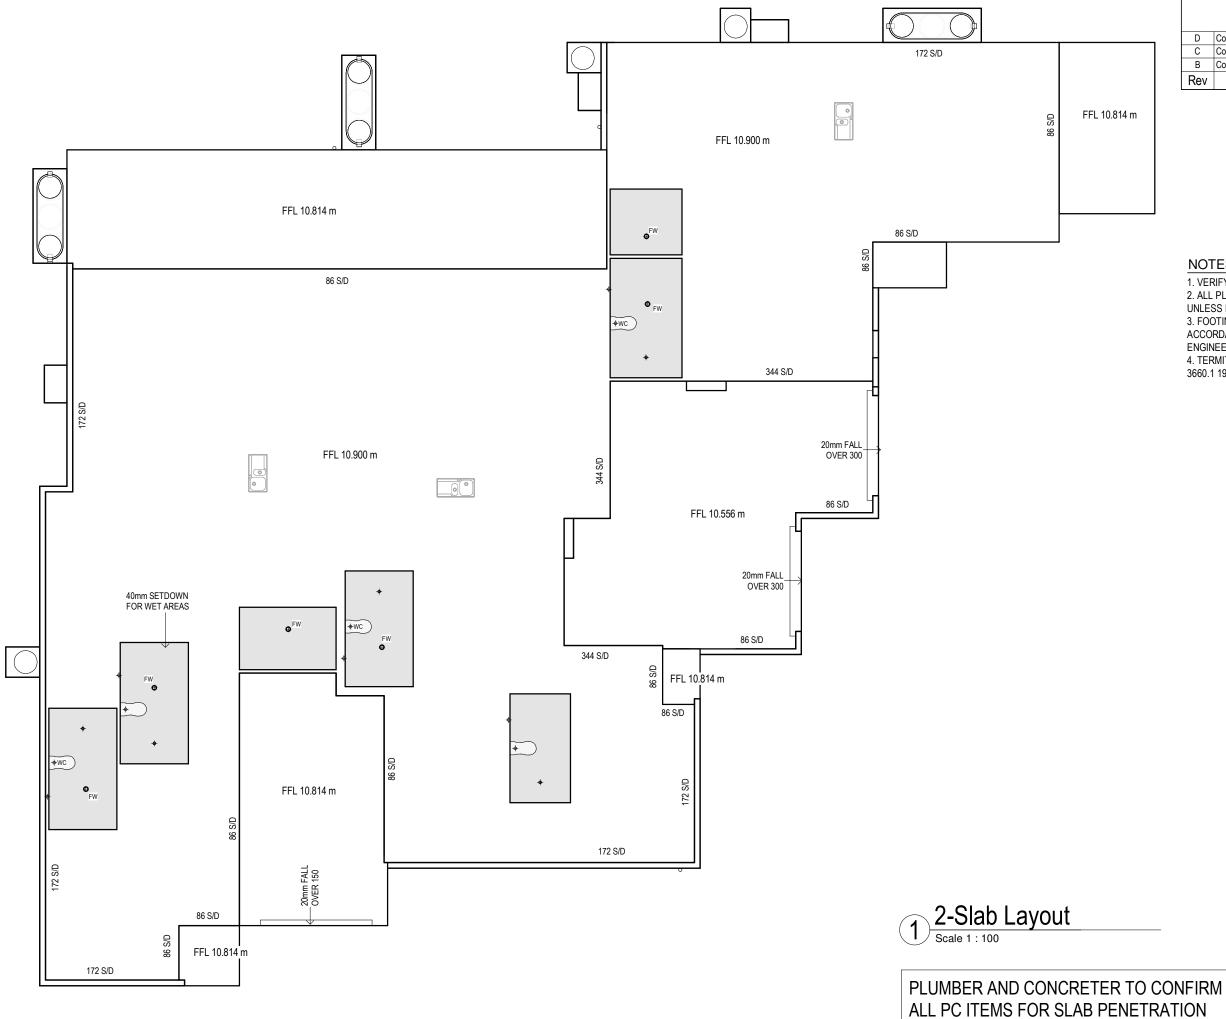

D	Council Issue Updates	18.01.25
С	Council Issue	22.10.24
В	Concept Issue	10.08.24
Rev	Amendment	Date


FFL 10.814 m

NOTES

1. VERIFY ALL DIMENSIONS PRIOR TO COMMENCEMENT. 2. ALL PLAN DIMENSIONS ARE TO OUTSIDE OF BRICK WORK UNLESS NOTED OTHERWISE. 3. FOOTINGS AND SLAB CONSTRUCTION TO BE IN ACCORDANCE WITH ANY GEOTECHNICAL REPORT & ENGINEER'S DETAIL FOR THIS ALLOTMENT. 4. TERMITE PROTECTION TO BE IN ACCORDANCE WITH AS 3660.1 1995 AND B.C.A. 3.1.3.

CLIENT DATE//		
BUILDER DATE/		
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141-24		
FOR		
LOGAN		
AT LOT 59 DP1297467 No. 22 DRIFTWOOD BOULEVARD OLD BAR 2430		
TITLE		
SLAB LAYOUT		
BASIX CERT. No.	1768115M	
SCALE	1 : 100	
DATE	18/01/2025	
DRAWN	T.J.W	
SHEET SIZE:	A3	
JOB No.	DWG No. 05-1	

OFFSETS AND DIMENSIONS

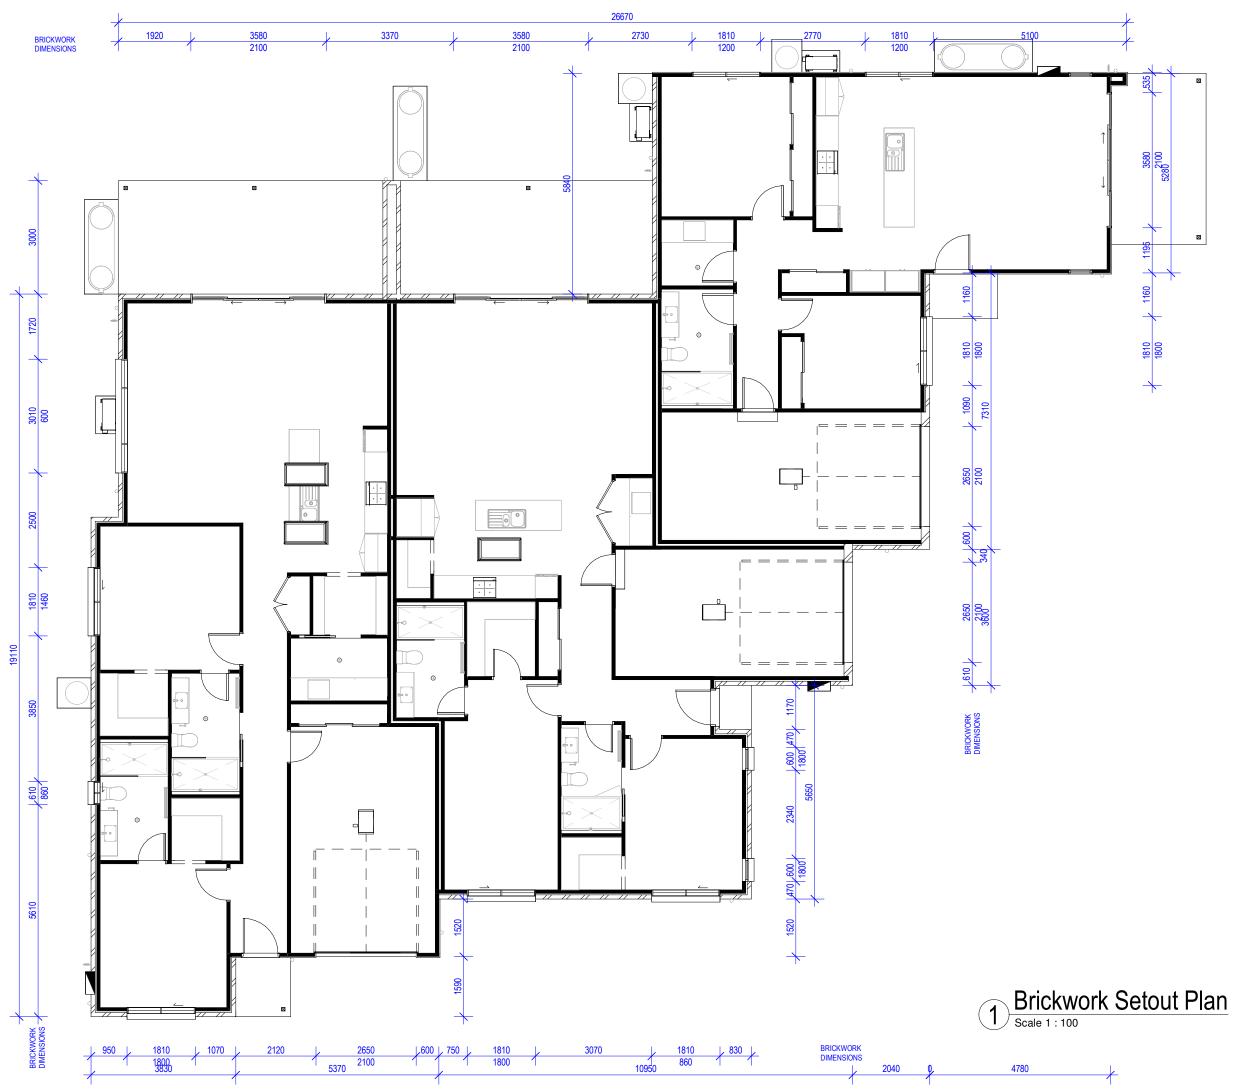

D	Council Issue Updates	18.01.25
С	Council Issue	22.10.24
В	Concept Issue	10.08.24
Rev	Amendment	Date

CLIENT DATE/		
BUILDER DATE/		
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141-24		
FOR		
LOGAN		
AT LOT 59 DP1297467 No. 22 DRIFTWOOD BOULEVARD OLD BAR 2430		
TITLE		
BRICKWORK SETOUT		
	1768115M	
SCALE	1:100	
DATE DRAWN	18/01/2025 T.J.W	
SHEET SIZE:	A3	
JOB No.	DWG No. 05-2	